A CONTRACT FOR CONSTRUCTION, THE CONTRACTOR AGREES THAT, IF IT RAISED NO QUESTIONS REGARDING SUCH CONFLICTS DURING THE BIDDING PROCESS, AND IN THE ABSENCE OF A CLARIFYING ADDENDUM ISSUED DURING THE BIDDING PROCESS, IT HAS VOLUNTEERED TO COMPLY WITH THE MORE EXPENSIVE REQUIREMENT AS PART OF ITS BASE BID AND IS NOT ENTITLED TO ANY ADDITIONAL COMPENSATION TO RESOLVE THE CONFLICT. 9. THE CONTRACT DOCUMENTS REQUIRE THE CONTRACTOR TO FURNISH AND INSTALL COMPLETE PRODUCTS, SYSTEMS							204
	AND SERVICES. BY EXECUTING A CONTRACT FOR CONSTRUCTION, THE COFORTH THE DESIGN INTENT AND, THEREFORE, MAY NOT EXPRESSLY DEPICOMPONENT OR UNIT OF A PRODUCT, SYSTEM OR SERVICE. THE CONTRAITS BID, IT MUST FURNISH AND INSTALL EVERY LENGTH, SEGMENT, PIECE PRODUCT, SYSTEM OR SERVICE AND, CONSEQUENTLY, THE CONTRACTOR COMPENSATION FOR ANY LENGTH, SEGMENT, PIECE, PART COMPONENT OF	ONTRACTOR AGREES THAT ICT EVERY LENGTH, SEGME ACTOR FURTHER AGREES TE, PART, COMPONENT OR US NOT ENTITLED TO ANY	THE DRAWINGS SET NT, PIECE, PART, HAT, AS PART OF JNIT OF A ADDITIONAL			DOOR NO. NEW DOOR NO. EXISTING	203.2 203.1X
	BECAUSE IT IS NOT EXPRESSLY DEPICTED HEREIN.					NOMINAL THICKNESS — CONSTRUCTION TYPE — SPECIAL CONDITION —	M8b
						KEYNOTE IDENTIFICATION	7.531
						WINDOW TYPE IDENTIFICATION	⊗
		STANDA	RD ABBREVIATIONS			TOILET ACCESSORY IDENTIFICATION	A
@ A B	AT ANCHOR BOLT	EWH EXIST	ELECTRIC WATER HEATER EXISTING	PTN PVMT	PARTITION PAVEMENT		78.
ABR ACP ACT AFF	ABRASIVE ACOUSTICAL CEILING PANEL ACOUSTICAL CEILING TILE ABOVE FINISH FLOOR	EXP EXP CONST FD FDN	EXPANSION EXPOSED CONSTRUCTION FLOOR DRAIN FOUNDATION	PC PL PLAM PL	PIECE PLATE PLASTIC LAMINATE(D) PLASTER	SPOT ELEVATION	11/51/0°
AFG ACOU ADD'N	ABOVE FINISH GRADE ACOUSTIC ADDITION	FNDN FE FEC	FOUNDATION FIRE EXTINGUISHER FIRE EXTINGUISHER CABINET	PLB'G PLB'G CONTR PLYWD	PLUMBING PLUMBING CONTRACTOR PLYWOOD	A A A	CONCRETE
ADD'L ADJ AL	ADDITIONAL ADJACENT OR ADJUSTABLE ALUMINUM	FHC FIN FLR FRT	FIRE HOSE CABINET FINISH FLOOR FIRE RETARDANT TREATED	PNT PO PVC	PAINT PRECAST (CONCRETE) OPENING POLYVINYL CHLORIDE		BRICK MASONRY IN PLAN
ALT ANCHF AP APPR(ACCESS PANEL	FUR CHN'L FTG GA	FURRING CHANNEL FOOTING GAUGE	PL-(1) R R OR RAD RD	GYPSUM PLASTER (TYPE) RISER RADIUS ROOF DRAIN		CONCRETE MASONRY IN PLAN (RUNNING BOND)
ASPH AUTO AVG BSMT		GALV GEN CONTR GC GL	GALVANIZED GENERAL CONTRACTOR GENERAL CONTRACTOR GLASS	RO RF (1) RH	ROUGH OPENING RUBBER FLOORING (TYPE) RIGHT HAND		CONCRETE MASONRY IN PLAN (STACK BOND)
BSMI B/ BD BET	BOTTOM OF BOARD BETWEEN	GYP BD-(1) GYP PL-(1) H	GYPSUM WALL BOARD (TYPE) GYPSUM PLASTER (TYPE) HIGH	REF REINF REQ'D	REFERENCE REINFORCE/REINFORCING/REINFORCED REQUIRED		STONE MASONRY IN PLAN
BIT BLDG BLKG	BITUMINOUS BUILDING BLOCKING (WOOD)	HD HDNR HD WD-(1)	HEAVY DUTY OR HARD HARDENER HARD WOOD (TYPE)	RM SF SI SK	ROOM SQUARE FOOT SQUARE INCH SINK		RAKED JOINT IN PLAN CTRL./EXP. JOINT IN PLAN
BM B.M. BRG BRKT	BEAM BENCH MARK BEARING BRACKET	HDWR HT HM HP	HARDWARE HEIGHT HOLLOW METAL HIGH POINT	SS SSK SQ	STAINLESS STEEL SERVICE SINK SQUARE		BRICK MASONRY IN SECTION DETAIL
BRK BT ST CJ	BRICK L PL BENT STEEL PLATE CONSTRUCTION OR CONTRACTION JOINT	HORIZ HTG HVAC	HORIZONTAL HEATING HEATING/VENTILATING/AIR CONDITIONING	SCHED SEAL/HDNR SEC SHT	SCHEDULE SEALER/HARDENER SECTION SHEET		CONCRETE MASONRY IN SECTION DETAIL
CAB CEM F CT PA CIP	, ,	IN ID INCL INSUL	INCH INSIDE DIAMETER INCLUDE/INCLUDING/INCLUDED INSULATION/INSULATING/INSULATED	SIM SOG SPEC(S)	SIMILAR SLAB ON GRADE SPECIFICATION(S)		STONE MASONRY IN SECTION DETAIL
CLG CLR C.O.	CEILING CLEAR CLEAN—OUT	JT KD L	JOINT KNOCK DOWN LONG	SPC'G SPK'R STD STD WT	SPACING SPEAKER STANDARD STANDARD WEIGHT		STEEL IN SECTION DETAIL
CMU COL COMB COMP		LAM LAV LH LP	LAMINATE/LAMINATING/LAMINATED LAVATORY LEFT HAND LOW POINT	STL STRUCT SUSP	STEEL STRUCTURE OR STRUCTURAL SUSPEND(ED)		DISCONTINUOUS ROUGH WOOD BLOCKING IN SECTION
CONC COND CONT	OPNG CONCRETE OPENING	LT WT LL LLH	LIGHTWEIGHT LIVE LOAD LONG LEG HORIZONTAL	SYM T T&G T/BEAM	SYMMETRICAL TREAD TONGUE AND GROOVE TOP OF		CONTINUOUS ROUGH WOOD FRAMING/BLOCKING IN SECTION
CONTR CONTR CPT-(1	CONTRACT(OR) CARPET (TYPE)	LLV LVR MO MT	LONG LEG VERTICAL LOUVER MASONRY OPENING METAL THRESHOLD	T/BEAM T/C T/FNDN	TOP OF BEAM TOP OF CURB TOP OF FOUNDATION		FINISHED WOOD IN SECTION DETAIL
CTR CTR S CTRS	COUNTER K COUNTER SINK CENTER(S)	MAS MATL MAX	MASONRY MATERIAL MAXIMUM	T/STL T/WALL TB (4)	TOP OF STEEL TOP OF WALL TACKBOARD (LENGTH IN FEET)		RIGID BOARD INSULATION
CUH CUV DIA DIM	CABINET UNIT HEATER CABINET UNIT VENTILATOR DIAMETER DIMENSION	MB (16) MECH MECH CONTR MFR	MARKERBOARD (LENGTH IN FEET) MECHANICAL MECHANICAL CONTRACTOR MANUFACTURER	T/MAS TYP UD	TOP OF MASONRY TYPICAL (WINDOW) UNIT DIMENSION		RIGID BOARD INSULATION (ROOFING)
DN DO DR	DOWN DOOR OPENING DOOR	MIN MISC MSB	MINIMUM OR MINUTE(S) MISCELLANEOUS MOP SERVICE BASIN (SINK)	UNO VBC VBS VCT	UNLESS NOTED OTHERWISE VINYL BASE COVED VINYL BASE STRAIGHT VINYL COMPOSITION TILE		BATT INSULATION
DWGS DTL DWL'S EA	DETAIL	MT(D) MTL NIC NOM	MOUNT(ED) METAL NOT IN CONTRACT	VEN PL (1) VERT W	VENEER PLASTER (TYPE) VERTICAL WIDE OR WIDTH		GYPSUM BOARD
EJ EL ELEC	EXPANSION JOINT ELEVATION ELECTRIC/ELECTRICAL CONTR ELECTRICAL CONTRACTOR	NOM NTS NO OA OC	NOMINAL NOT TO SCALE NUMBER OVERALL OR OUTSIDE AIR ON CENTER	W/O WCG WD	WITH WITHOUT WALL CORNER GUARD WOOD		ACOUSTICAL CEILING PANEL
LLLU	JOHAN ELECTRICAL CONTINACION	1 00	OIT OLITICIN	MDM	WINDOW		

WINDOW

WATER PROOF

WELDED WIRE FABRIC

WALL SERVICE BASIN

WDW



PROJECT

DR

A12.24

-\A7.19 /

(26)

100'-0"

BITUMINOUS

(ASPHALT) PAVING

BALLAST, FILL OR BACKFILL IN

CONCRETE

AGGREGATE

SECTION

UNDISTURBED

EARTH BACKFILL

DETAIL NUMBER-

DRAWING NUMBER —

DETAIL NUMBER—

DRAWING NUMBER —

DETAIL NUMBER -DRAWING NUMBER -

DETAIL NUMBER -

COLUMN NO

ELEVATION

REFERENCE LINE NO.

DRAWING NUMBER — A6.05

RAY HARTSTEIN CAMPUS GENERATOR REPLACEMENT 7701 N. LINCOLN AVENUE SKOKIE, ILLINOIS

OWNER

OAKTON COLLEGE 1600 EAST GOLF ROAD DES PLAINES, ILLINOIS

ARCHITECT/ **ENGINEER**


KLUBER ARCHITECTS + ENGINEERS 41 W BENTON STREET AURORA, ILLINOIS 60506 TEL (630) 406-1213 FAX (630) 406-9472 www.kluberinc.com

G100 COVER SHEET, GENERAL NOTES, SYMBOLS, & DRAWING INDEX

INDEX OF DRAWINGS

ME100 SYMBOLS LIST AND PANELS SCHEDULE ME305 BASEMENT LEVEL MECHANICAL AND ELECTRICAL PLAN ME316 PARTIAL FIRST FLOOR MECHANICAL AND ELECTRICAL


E410 ELECTRICAL ONE LINE DIAGRAM — REMODELED

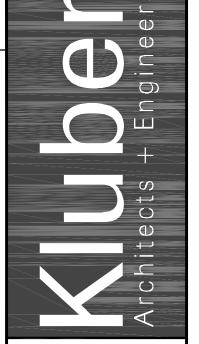


SEALS & CERTIFICATIONS

I HAVE PREPARED, OR CAUSED TO BE PREPARED UNDER MY DIRECT SUPERVISION, THE ATTACHED PLANS AND SPECIFICATIONS AND STATE THAT TO THE BEST OF MY KNOWLEDGE AND BELIEF, AND TO THE EXTENT OF MY CONTRACTUAL OBLIGATION, THEY ARE IN COMPLIANCE WITH IBC 2018 EDITION, THE ENVIRONMENTAL BARRIERS ACT AND THE ILLINOIS ACCESSIBILITY


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"G" SERIES, "P" SERIES, "M" SERIES, "F" SERIES

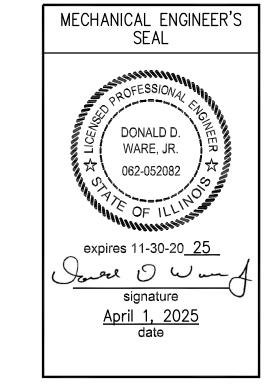

"G" SERIES, "E" SERIES

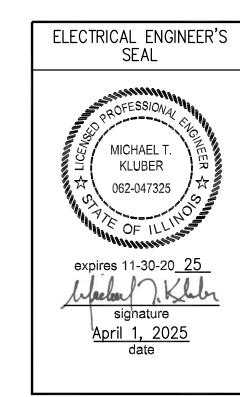

SHEET TITLE COVER SHEET, **GENERAL NOTES,** SYMBOLS AND

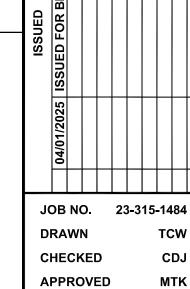DRAWING INDEX

SHEET NUMBER

P:\1484 - Oakton College - Skokie Generator\30_Design\Dwgs\DD-CD\01_Gen\1484G0100.dwg, 4/1/2025 10:48:57 AM, Bluebeam PDF (BW).pc3

THE MATERIALS, ABBREVIATIONS, AND DRAFTING SYMBOLS LEGEND ARE EACH AN ALL INCLUSIVE MASTER LIST USED BY THIS FIRM. THE INCLUSION OF THESE LEGENDS INTO THESE DOCUMENTS DOES NOT IMPLY THAT ALL THE SYMBOLS OR MATERIALS INCLUDED IN THESE LEGENDS ARE INCORPORATED INTO THIS PROJECT. ABBREVIATIONS MAY APPEAR WITH PERIODS OR OTHER PUNCTUATION SEPARATING CHARACTERS ON THE DRAWINGS; THE MEANING REMAINS THE SAME.

OUTSIDE DIAMETER

OUTSIDE FACE OR OPPOSITE FACE

OPPOSITE OR OPPOSITE HAND

PRESSURE TREATED OR PAINT

POUNDS PER SQUARE FOOT

POUNDS PER SQUARE INCH

OPNG

ELEVATOR OR ELEVATION

ELECTRIC WATER COOLER

EMBEDMENT

EMERGENCY

EACH WAY

EPOXY

EMBED

EMER


ΕW

G100

	ELECTRICAL S	YMB	OLS	LIS	T		ELECTRICA	L PANEL SCHEDULES
SYMBOL CEILING WALL FLOOR	DESCRIPTION	CEILING	SYMBOL WALL		DESCRIPTION			
CLILING WALL IT LOOK	LUMINARIES	CLILING	WALL	I LOOK	POWER EQUIPMENT & DEVICES		DEDI 4	
	2X4 FLUORESCENT FIXTURE TYPE. SEE LIGHTING FIXTURE SCHEDULE. SHADING=NIGHT LIGHT	\$ _T	\$ _T		MANUAL MOTOR STARTER OR 1P DISCONNECT SWITCH WITH THERMAL OVERLOAD PROTECTION.		BEDL1	277/480 VOLT, 3 PHASE, 4 WIRE, FRONT ACCESSIBLE, N 400 AMPERE, MAIN LUG ONLY, FUSIBLE SECTIONS, EXISTING TO REMAIN (SQUARE D QMB STYLE)
	2X2 FLUORESCENT FIXTURE TYPE. SEE LIGHTING FIXTURE SCHEDULE. NIGHT LIGHT AND EMERGENCY FIXTURE.		\$ _{sc}		SPEED CONTROL SWITCH FURNISHED BY MECHANICAL CONTRACTOR, INSTALLED AND WIRED BY ELECTRICAL CONTRACTOR.	CKT 1	AMP FUSE DESCRIPTION SPARE	AMP FRAME A B C
	FIXTURE WITH NORMAL/EMERGENCY LIGHTING TRANSFER DEVICE. SEE LIGHTING FIXTURE SCHEDULE.		•		UP/DOWN/STOP PUSHBUTTON CONTROL STATION.	2 3	SPARE 30 SUMP PUMP SP1	30/3 0.33 0.33 0.33
	4' FLUORESCENT INDIRECT FIXTURE TYPE. SEE LIGHT FIXTURE SCHEDULE. 4' FLUORESCENT STRIP FIXTURE TYPE. SEE LIGHT FIXTURE SCHEDULE.	마			SAFETY SWITCH. N=NON-FUSED (AMPS/POLES/ENCLOSURE). F=FUSED (AMPS/FUSE/POLES/ENCLOSURE).	4 5	3 EJECTOR PUMP SE-1 25 BETX PANEL BEP1	30/3 3.00 3.00 3.00 3.00 3.00
	A= FIXTURE TYPE, 2= CIRCUIT ASSIGNMENT, a=SWITCH LEG DOWN LIGHT FIXTURE TYPE. SEE LIGHTING FIXTURE SCHEDULE.				MAGNETIC MOTOR STARTER. NEMA SIZE AS NOTED. COMBINATION MAGNETIC MOTOR STARTER AND FUSED DISCONNECT SW.	6 7	3 EJECTOR PUMP SE-2 45 PANEL BEL1	30/3 1.00 1.00 1.00 60/3 1.40 1.40 1.40
<u> </u>	TRACK LIGHT FIXTURE TYPE. SEE LIGHTING FIXTURE SCHEDULE.	HP		(HP)	(AMPS/FUSE/POLES/NEMA SIZE). MOTOR. HP= HORSE-POWER RATING.	8 9	45 PANEL 1C-EL1 50 ELEVATOR #2	60/3 4.30 4.30 4.30 100/3 13.33 13.33 13.33
	WALL MTD. FIXTURE TYPE. SEE LIGHTING FIXTURE SCHEDULE.				ELECTRIC HEAT OUTLET	10	100 PANEL 1B-EL1	100/3 14.36 14.36 14.36
	SELF CONTAINED EMERGENCY BATTERY PACK W/ BATTERY BACK-UP SEE LIGHTING FIXTURE SCHEDULE.		• _{DO}		DOOR OPENER	-		TOTAL WATTS 40.72 40.72 40.72 TOTAL AMPS 147.00 147.00 147.00
	LED EXIT SIGN. ARROWS AS INDICATED. SEE LIGHTING FIXTURE SCHEDULE. WG= WIRE GUARD, PG= PLEXIGLASS SHIELD.			6	PANEL 240V & BELOW.			
A B	EM/EXIT COMBO UNIT. SEE LIGHTING FIXTURE SCHEDULE.							
	SINGLE POLE TOGGLE SWITCH. 15A OR 20A AS REQUIRED. 120/277V a=SWITCHING CONTROL, P=PILOT LIGHT, K=KEYED SW., LV=LOW VOLTAGE 3-WAY TOGGLE SWITCH. 15A OR 20A AS REQUIRED. 120/277V				GENERATOR REMOTE ANNUNCIATOR PANEL.			
\$3 AC	3=3 WAY DIMMER SINGLE POLE TOGGLE SWITCH. 15A OR 20A AS REQUIRED. 120/277V		RAP		EQUIPMENT CONTROL PANEL			
φE	a=SWITCHING CONTROL, AC = ABOVE COUNTER MOMENTARY CONTACT SWITCH FOR SHUT-OFF OF ELECTRICAL RECEPTACLES	PB	PB	PB	PULL BOX. SIZE AS NOTED.	-		
	IN LAB CLASSROOMS LIGHTING CONTROL DIMMER SWITCH. SIZE AS INDICATED.		P		POWER/TELEPHONE/DATA POLE OR MULTI CHANNEL METAL RACEWAY VERTICAL RUN. REFER TO DRAWINGS & DETAILS.			
\$ _{MC}	MOMENTARY CONTACT SWITCH.		C		ELECTRICALLY HELD LIGHTING CONTACTOR. SIZE, COIL VOLTAGE, AND NUMBER OF POLES AS INDICATED.			
\$ _L	ILLUMINATED SWITCH.		TC		ELECTRONIC TIME CLOCK.	1		
(S) \$ _{0S}	VACANCY SENSOR SWITCH.		PP		POWER POLE			
\$ _{LMC}	LIGHTING MASTER CONTROLLER.		©		PHOTOCELL.			
			.2		FLEXIBLE CONDUIT CONNECTION.			
	WIRING DEVICES & OUTLETS SPECIAL PURPOSE SINGLE RECEPTACLE. @18"AFF				WIRING IN CONDUIT CONCEALED ABOVE CEILING, IN WALL AND UNDER FLOOR OR UNDERGROUND. WIRING IN CONDUIT EXPOSED ON CEILING OR WALL.			
	MATCH CONFIGURATION TO EQUIPMENT. DUPLEX RECEPTACLE. 20A 125V 2P 3W GRD. NEMA5-20R. @18"AFF	•	<u> — </u>	· HHI	BRANCH CIRCUIT WIRING IN CONDUIT HOMERUN TO PANEL. ONE ARROW			
	D=DEDICATED CIRCUIT. 'I' =MTD. @48"AFF, OR @6" ABOVE COUNTER. GFCI(GROUND FAULT CIRCUIT INTERRUPTER) PROTECTED RECEPTACLE.			<i>></i> ' ''' ∑	PER HOMERUN. SLASHES INDICATE NUMBER OF CONDUCTORS. INDICATES GROUND CONDUCTOR.	-		
<u> </u>	WP=WEATHER PROOF. 20A 125V 2P 3W GRD. NEMA5-20R. @18"AFF GFCI(GROUND FAULT CIRCUIT INTERRUPTER) PROTECTED RECEPTACLE MTD. @48"AFF, OR @6" ABOVE COUNTER.		•		INDICATES ISOLATED GROUND CONDUCTOR.			
	ISOLATED GROUND(IG) RECEPTACLE. @18"AFF 20A 125V 2P 3W GRD. NEMA5-20R OR AS SPECIFIED.		RISER	PLAN				
	DOUBLE DUPLEX RECEPTACLE. @18"AFF 20A 125V 2P 3W GRD. NEMA5-20R. PO=POP UP RECEPTACLE		E° / N	ATS	AUTOMATIC TRANSFER SWITCH			
 	DOUBLE DUPLEX RECEPTACLE NEXT TO VIDEO OUTLET IN 2-GANG JBOX. REFER TO VIDEO OUTLET DETAIL. 20A 125V 2P 3W GRD. NEMA5-20R.				PANEL ABOVE 240V.			
	@96"AFF		<u> </u>	П	TRANSFORMER. TYPE AND RATINGS ARE AS SHOWN.			
₽ / ₽ ♥	POP OPEN ENCLOSURE WITH GFCI(GROUND FAULT CIRCUIT INTERRUPTER) PROTECTED RECEPTACLE OR GFCI RECEPTACLE AND DATA JACK PEDESTAL MOUNTED GFCI RECEPTACLE FOR COUNTERTOP							
PD	FURNITURE RECEPTACLE. COORDINATE WITH FURNITURE OR CABINET							
	MANUFACTURER. 20A 125V 2P 3W GRD. NEMA5-20R OR AS SPECIFIED. TAMPER PROOF DUPLEX RECEPTACLE. 20A 125V 2P 3W GRD. @18" AFF D=DEDICATED CIRCUIT. 'I' = MTD. @48"AFF, OR @6" ABOVE COUNTER.							
SERVICE EQUIPMENT BSWD#1	EQUIPMENT GROUNDING CONDUCTOR				GENERATOR SUPPLEMENTAL ELECTRODE EQUIPMENT GROUNDING CONDUCTOR			
SERVICE EQUIPMENT BSWD#2 G	EQUIPMENT GROUNDING CONDUCTOR	4–POLE TRAN	GROUN	EQUIPMENT IDING CONDU	CTOR N O 3-POLE TRANSFER SWITCH LOAD			
		GEN	ERA	TOF	R/ATS GROUNDING DETAIL SCALE: NTS			

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ELECTRICAL PANEL SCHEDULES		
		Q in e
BEDL1 277/480 VOLT, 3 PHASE , 4 WIRE, FRONT ACCESSIBLE, NEMA1 ENCL., 400 AMPERE, MAIN LUG ONLY, FUSIBLE SECTIONS,		
EXISTING TO REMAIN (SQUARE D QMB STYLE) AMP FUSE DESCRIPTION AMP FRAME A B C TOTAL SPARE		cts
SPARE 30 SUMP PUMP SP1 30/3 0.33 0.33 0.33 0.99 3 EJECTOR PUMP SE-1 30/3 3.00 3.00 3.00 9.00		+
30 SUMP PUMP SP1 30/3 0.33 0.33 0.33 0.99 3 EJECTOR PUMP SE-1 30/3 3.00 3.00 3.00 9.00 25 BETX PANEL BEP1 30/3 3.00 3.00 3.00 9.00 3 EJECTOR PUMP SE-2 30/3 1.00 1.00 1.00 3.00 45 PANEL BEL1 60/3 1.40 1.40 1.40 4.20 45 PANEL 1C-EL1 60/3 4.30 4.30 4.30 12.90		Arch
45 PANEL 1C-EL1 60/3 4.30 4.30 4.30 12.90 50 ELEVATOR #2 100/3 13.33 13.33 13.33 39.99 100 PANEL 1B-EL1 100/3 14.36 14.36 14.36 43.08		
TOTAL WATTS 40.72 40.72 40.72 122.16 TOTAL AMPS 147.00 147.00 147.00 146.94		Inc. nois 60506 6.1213 erinc.com
		Kluber, Inc. Aurora, Illinois 60 tel. 630.406.1213 www.kluberinc.cc
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		ISSUED
		04/01/2025
		JOB NO. 23-315-1484 DRAWN ATR

DRAWN CHECKED APPROVED SHEET TITLE SYMBOLS LIST AND PANEL SCHEDULES SHEET NUMBER E100

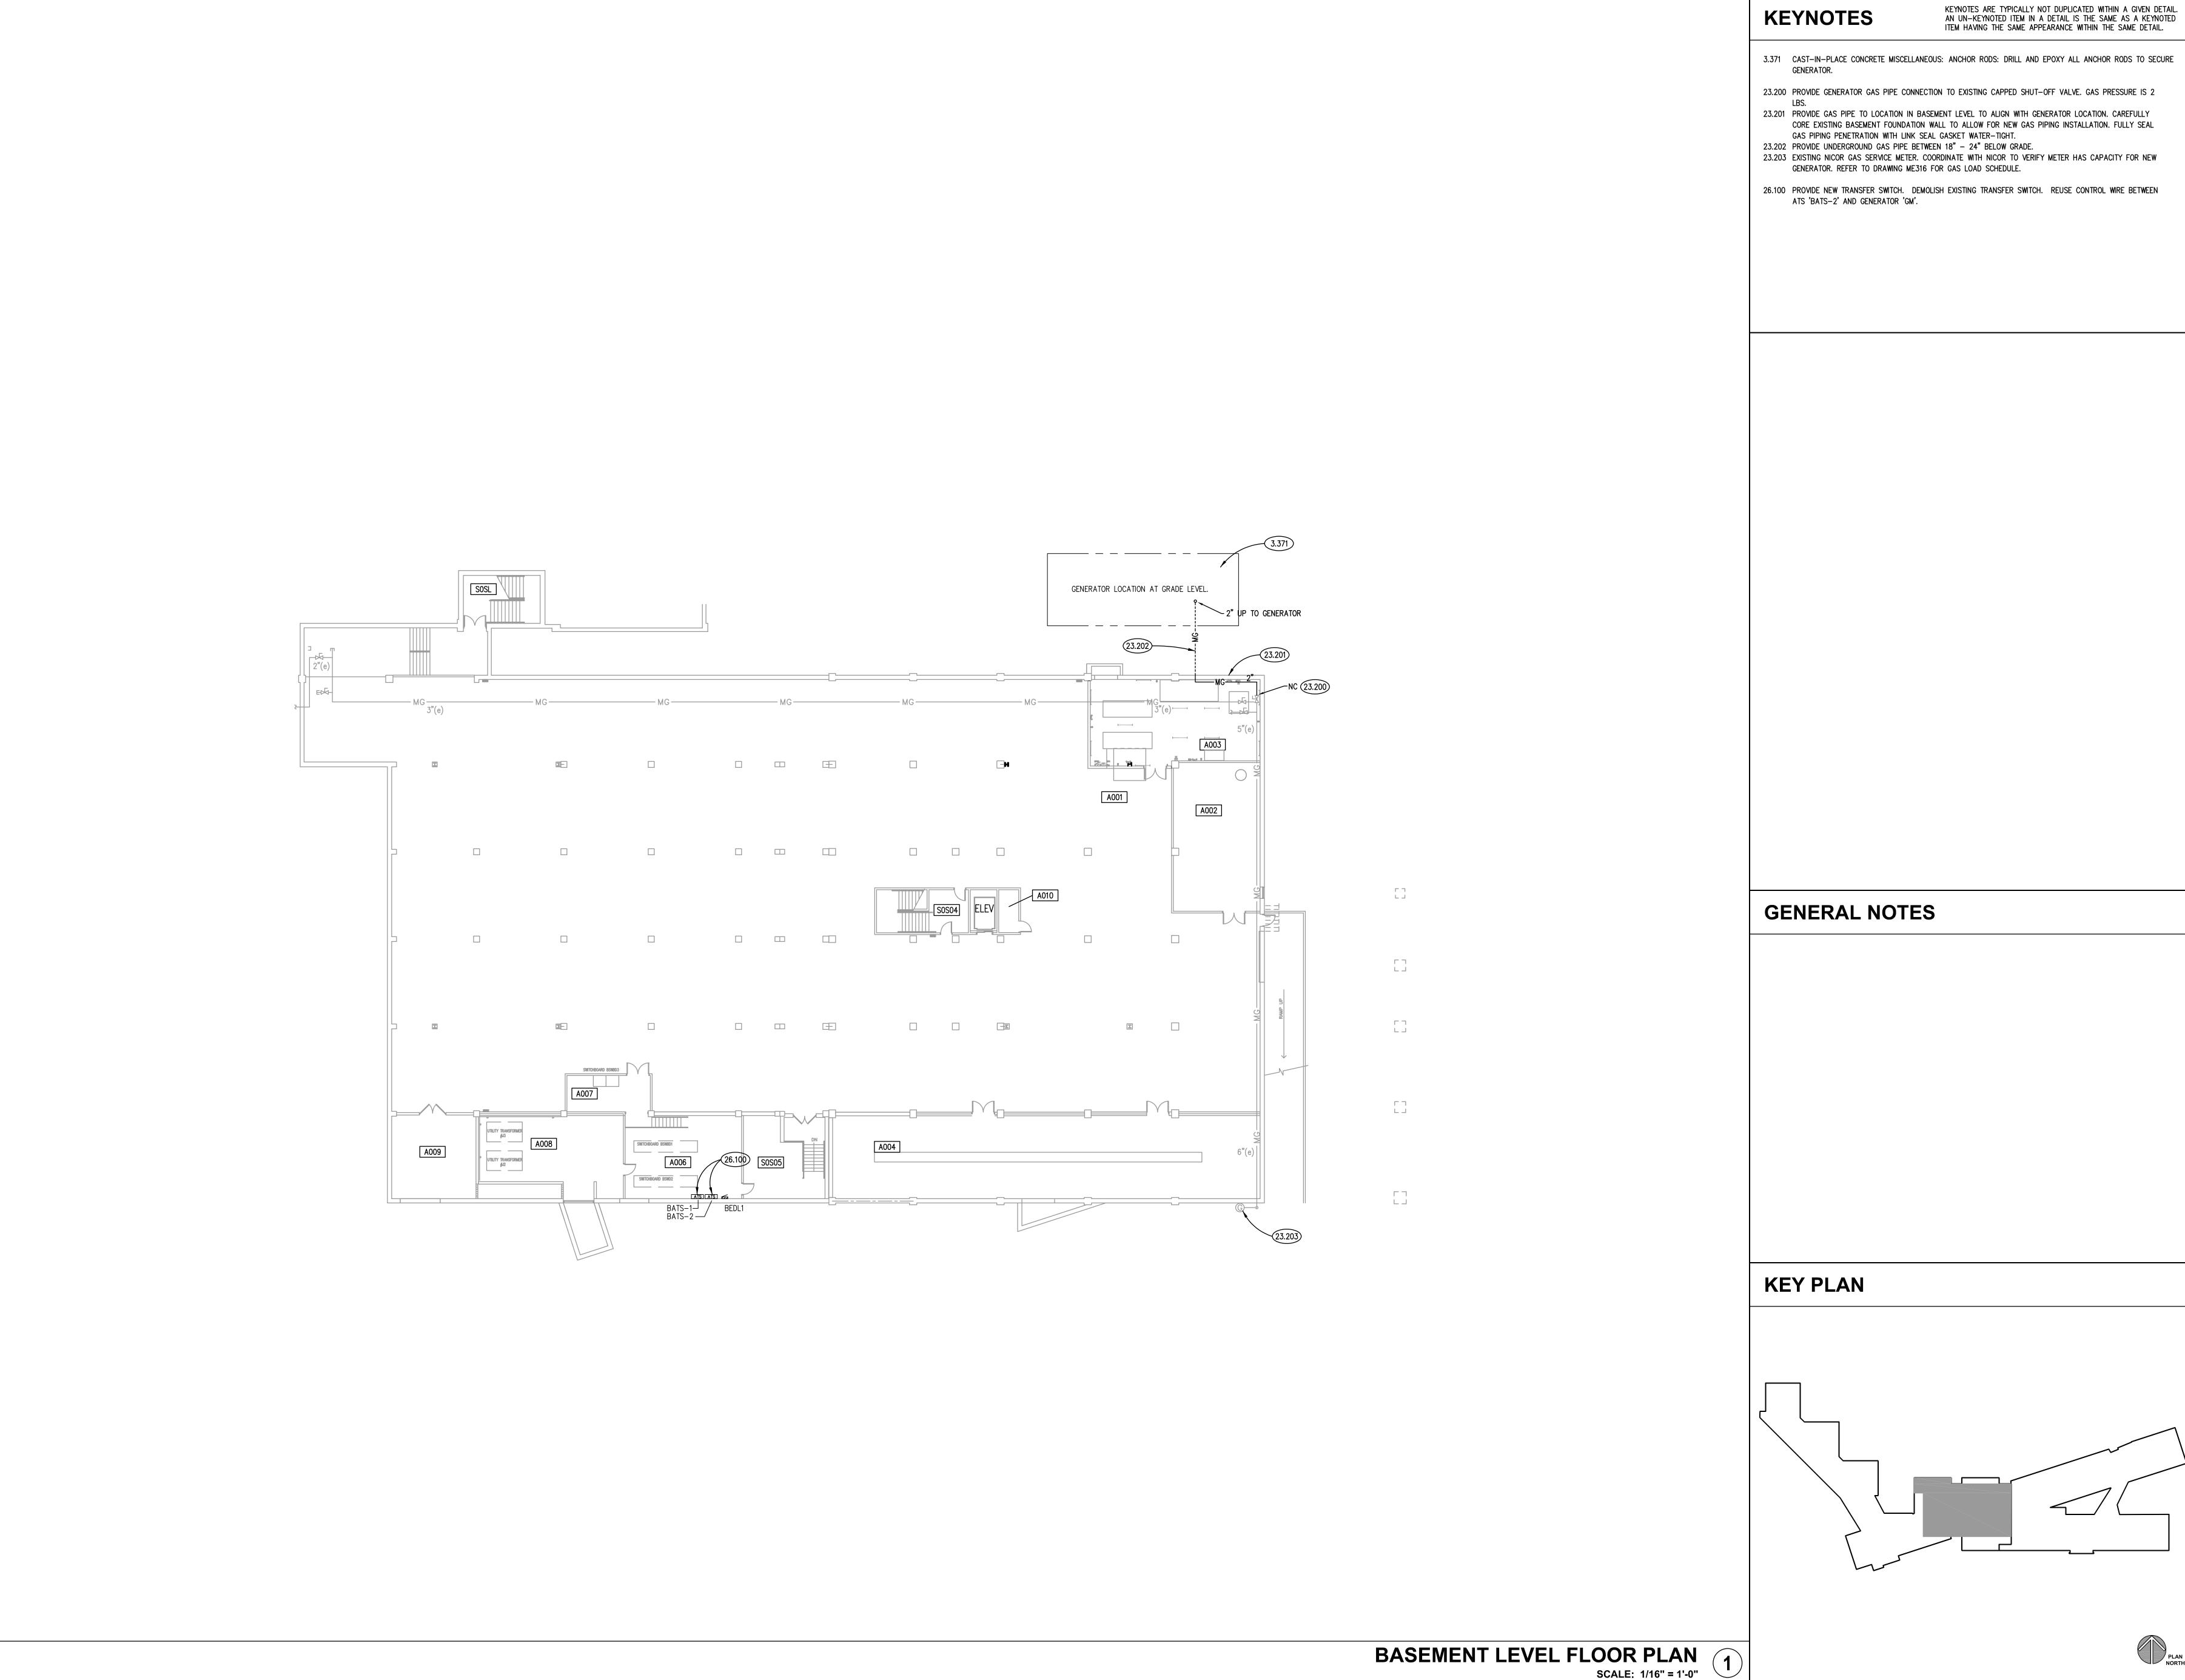

			I	Copyright © 2025 KLUBER, INC.	
	GAS	DEMAND SCH	EDULE	KEYNOTES	
	SYMBOL DESC B-1(e) BOILER	CRIPTION CFH 5500	REMARKS	2.100 REMOVE BUSHES AND BACKFILL TO GRADE. PROVIDE GRASS SEED BLANKET.	
	B-2(e) BOILER			23.204 PROVIDE GAS CONNECTION TO NEW GENERATOR. FIELD VERIFY EXACT GENERATOR GAS CONNECTION LOCATION WITH GENERATOR SUBMITTAL. PROVIDE GAS SHUT—OFF VALVE, GAS PRESSURE REGULATOR AND GAS PIPING CONFIGURATION AS RECOMMENDED BY GENERATOR MANUFACTURER.	
	WH-1(e) WATER H WH-2(e) WATER H			26.200 PROVIDE NEW GENERATOR. DEMOLISH EXISTING GENERATOR. REUSE 120 VOLT HEATER AND BATTERY CHARGING CIRCUITS.	ot s
	MAU-1(e) MAKE-UI SCIENCE LAB GAS COCKS(e) SCIENCE	UP AIR UNIT 200		26.201 SALVAGE: RETURN BATTERIES AND BATTERY CHARGER TO OWNER. 26.202 PROVIDE NEW REMOTE ANNUNICATOR PANEL AT SAME LOCATION. PROVIDE NEW CONTROL WIRING. REMOVE OLD PANEL.	
		N RANGE WITH OVEN 215			Archite
		N DOUBLE OVEN 90 BY GENERATOR 932	IT ROOM GENERATOR		60
	GM STANDBY	BY GENERATOR 2400	BUILDING GENERATOR		er, Inc. Illinois 60506. 406.1213
		TOTAL CFH 15,297			Kluber, Aurora, IIIi tel. 630.40
	P155 P156	STAR 1SO5		GENERAL NOTES	RAY HARTSTEIN CAMPUS - GENERATOR REPLACEMENT OAKTON COLLEGE 7701 N. LINCOLN AVE. SKOKIE, IL
CAME ROOM A190 RECEIVING A193 P114	P115			KEYPLAN	
P106 P107 P110 P111 P111 P110 P111 P110 P111 P110 P111 P110 P111 P110 P111 P110 P111 P111 P110 P					BIDDING
A170 A171 A194					ISSUEL SUED FOR SUED
A172 A173 P103 P104 P105 P112	P113				1/2025 IS
					04/0
A174 EXIT 23 EXIT 23	н				JOB NO. 23-315-1484 DRAWN MTK CHECKED MTK
EXIT 15 EXIT 15			NORTH		APPROVED MTK SHEET TITLE
					PARTIAL FIRST FLOOR MECHANICAL AND ELECTRICAL PLAN
					SHEET NUMBER
PARTIAL FI	IRST FLOOR MECHA	ANICAL AND EL		PLAN	ME316
Dakton College - Skokie Generator\30 Design\Dwgs\DD-CD\60 Flec\1484F0316 Sidwg 4/1/2025 10:44:58 AM Bluebeam PDF (BW)cdb nc3	T		SCALE: 1/16" = 1'-0"		

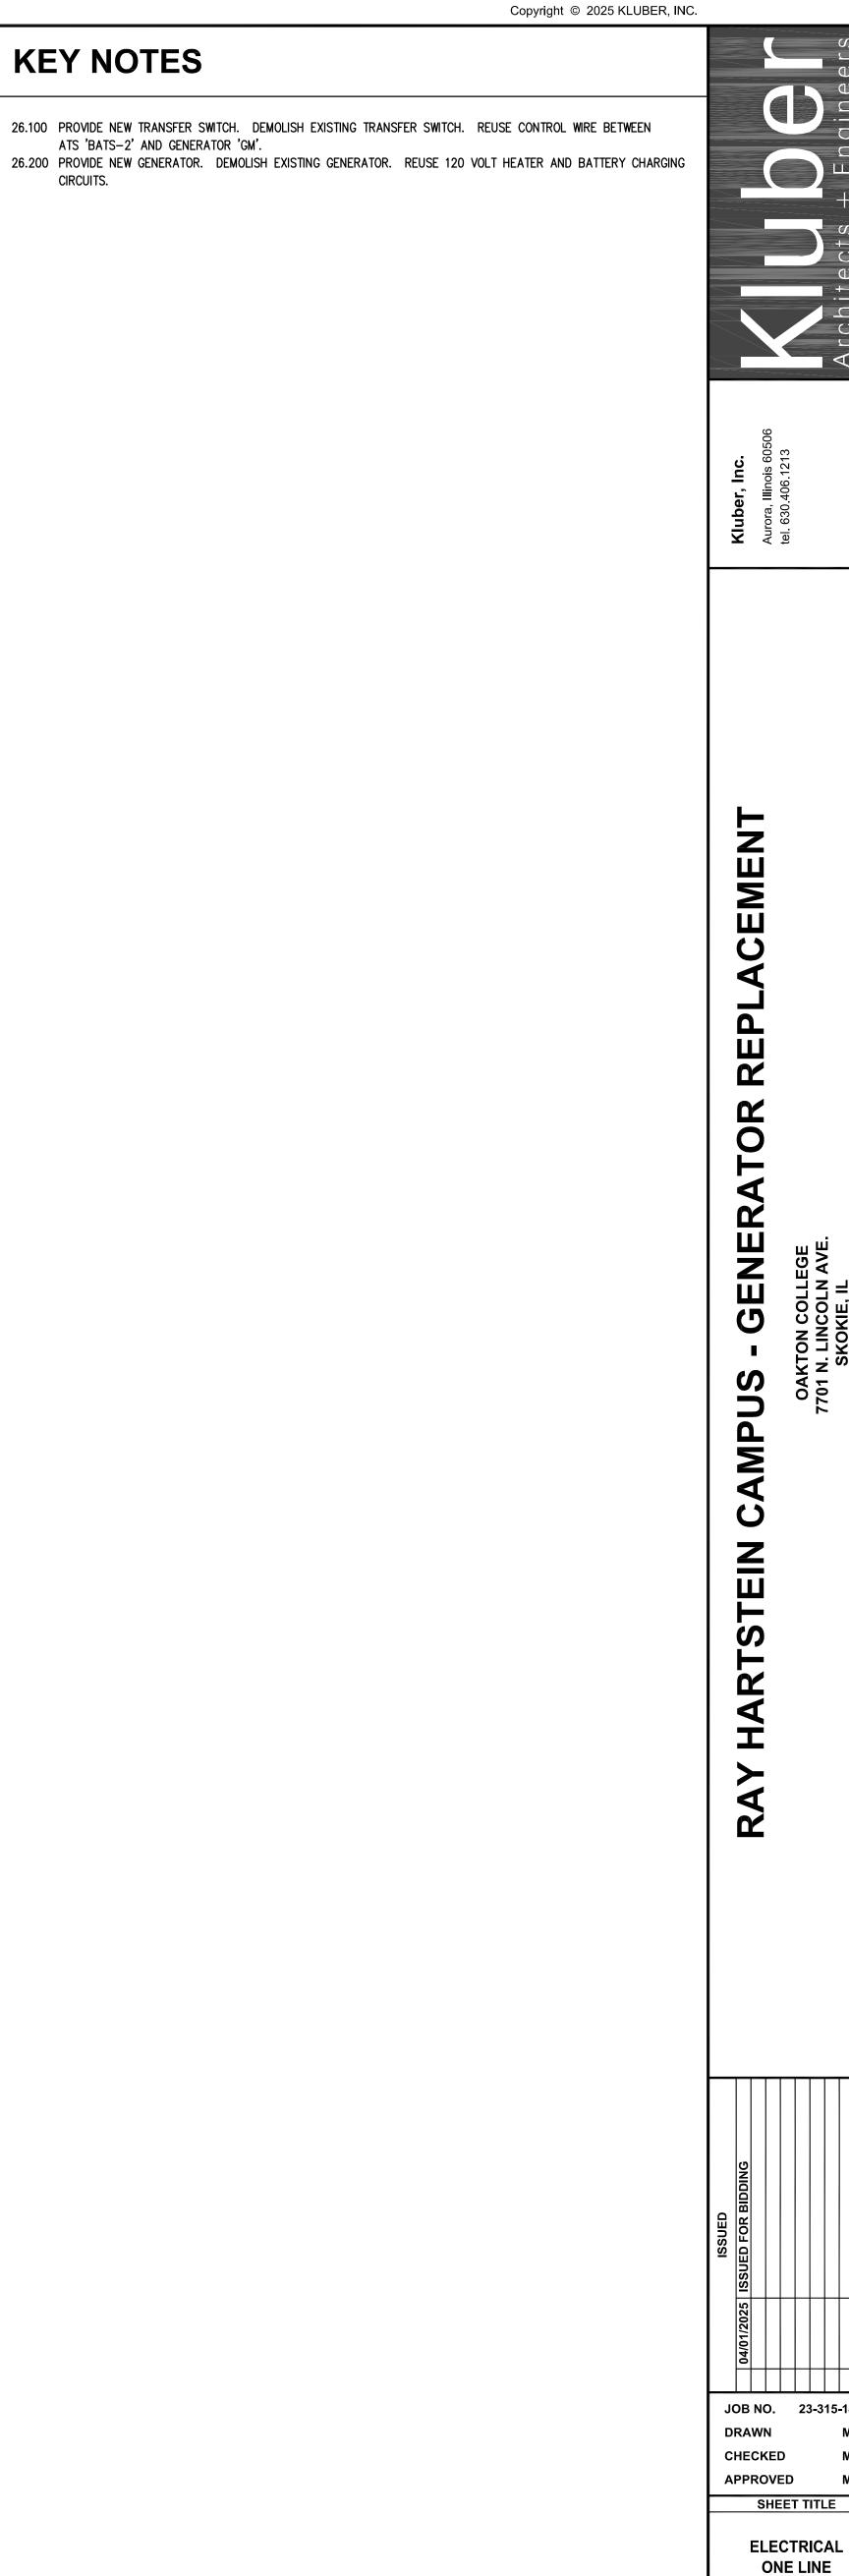


DIAGRAM -REMODELED SHEET NUMBER

E410

